

KEY LEGEND:					
	1200mm Long open channel fluorescent luminaire complete with 2 x 28W T5 lamp & ECG.		Distribution board		Single Phase Isolater wallmounted 1200mm AFFL
	Ceiling Mounted round IP65 bulkhead with 2 x 9W LED E27 epison screw, cool white lamps, unbreakable UV protected polycarbonate lenses and cast aluminium body and trim (black externally and white against ceilings).		External intercom speaker.		Single Phase Isolater
	Wall mounted round IP65 bulkhead with 2 x 9W LED E27 epison screw, cool white lamps, unbreakable UV protected polycarbonate lenses and cast aluminium body and trim (black externally and white against ceilings).		2 Way Speaker wall mounter intercom speaker.		Single Phase Isolater to be mounted in the ceiling void next to the geysers.
	Photo electric cell daylight switch.		230V, 16A, combination switched socket outlet white (with 1x standard 16A round pin socket + 1x 3 pin ZA plug socket) wall mounted at 300mm AFFL, suitable to accommodate SANS 164-1 & SANS 14-2 combination socket outlet as per GPDID guidelines.		Cold Room indoor cooling unit and condenser unit.
	1 Way light switch.		230V, 16A, combination switched socket outlet white (with 1x standard 16A round pin socket + 1x 3 pin ZA plug socket) wall mounted at 1100mm AFFL, suitable to accommodate SANS 164-1 & SANS 14-2 combination socket outlet as per GPDID guidelines.		
	2 Way light switch.				

**GENERAL NOTES:**

THIS DRAWING MUST BE READ IN CONJUNCTION WITH THE ELECTRICAL ENGINEER'S DRAWINGS AND ARCHITECTURAL LAYOUT DRAWINGS.

**GENERAL NOTES**

THIS DRAWING IS TO BE READ IN CONJUNCTION WITH ALL RELEVANT ARCHITECT'S AND ENGINEER'S DRAWING.

ALL DIMENSIONS, LEVELS, ETC. ARE TO BE CHECKED BEFORE ANY WORK IS COMMENCED AND ANY DISCREPANCIES NOTED TO BE BROUGHT TO THE ARCHITECT'S ATTENTION.

ONLY FIGURED DIMENSIONS TO BE USED. SCALING OF DRAWINGS IS NOT ADVISABLE.

ALL RIGHTS RESERVED. NO PARTS OF THIS DESIGN SHALL BE REPRODUCED, USED ELSEWHERE AND/OR IN ANY WAY WITHOUT PRIOR PERMISSION FROM THE ARCHITECT/ENGINEER.

**GEOTECH INFORMATION**

SOIL TYPE: \_\_\_\_\_

ASSUMED SOIL BEARING CAPACITY: \_\_\_\_\_ kPa

RECOMMENDED FOUNDATION TYPE: \_\_\_\_\_

RECOMMENDED FOUNDATION DEPTH: \_\_\_\_\_

REV No.	DATE	DESCRIPTION

**MUNICIPAL APPROVAL**

NAME: \_\_\_\_\_

SIGNATURE: \_\_\_\_\_ DATE: \_\_\_\_\_

STAMPS:

**CLIENT APPROVALS**

**North West Department of Education:**

NAME: \_\_\_\_\_ SIGNATURE: \_\_\_\_\_ DATE: \_\_\_\_\_

**DBSA Architect:**

NAME: \_\_\_\_\_ SIGNATURE: \_\_\_\_\_ DATE: \_\_\_\_\_

**DBSA OH&S:**

NAME: \_\_\_\_\_ SIGNATURE: \_\_\_\_\_ DATE: \_\_\_\_\_

**PRINCIPAL AGENT**

**KITSO BOTHALE**  
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COMPETENT CONTACT PERSON: Bruce Mutswara  
CONTACT No: +27 (0)12 663 1357  
FIRM REG No: T.B.C.



**DEPARTMENT OF BASIC EDUCATION**  
222 STRUBEN STREET  
PRETORIA

**DISCIPLINE**  
ARCHITECTURAL

**PROJECT NAME**  
Tshedimoso Primary School  
PORTION 1 OF THE FARM MOOIPAN No. 104 - IO  
MEASURING - 33 479 m<sup>2</sup>

**PROJECT STATUS**

STAGE 1-3	STAGE 4	STAGE 5-6
CONCEPT	TENDER	CONSTRUCTION
<input type="checkbox"/>	<input type="checkbox"/>	<input checked="" type="checkbox"/>

**DESCRIPTION**  
DINING & NUTRITION CENTRE (BLOCK 2)  
ELECTRICAL LAYOUT

SCALE: AS SHOWN

**DRAWN:** D. Basson  
**CHECKED:** M.L. van der Walt

REG No: PSAT 30522947  
SIGNATURE: \_\_\_\_\_


REG No: Pr.Arch. 7292  
SIGNATURE: \_\_\_\_\_

**PROJECT NUMBER**  
S-TSH-001-30

DATE: 11-10-2021

**OCCUPANCY CLASSIFICATION**  
A3

DWG No: 208  
REV No: 01

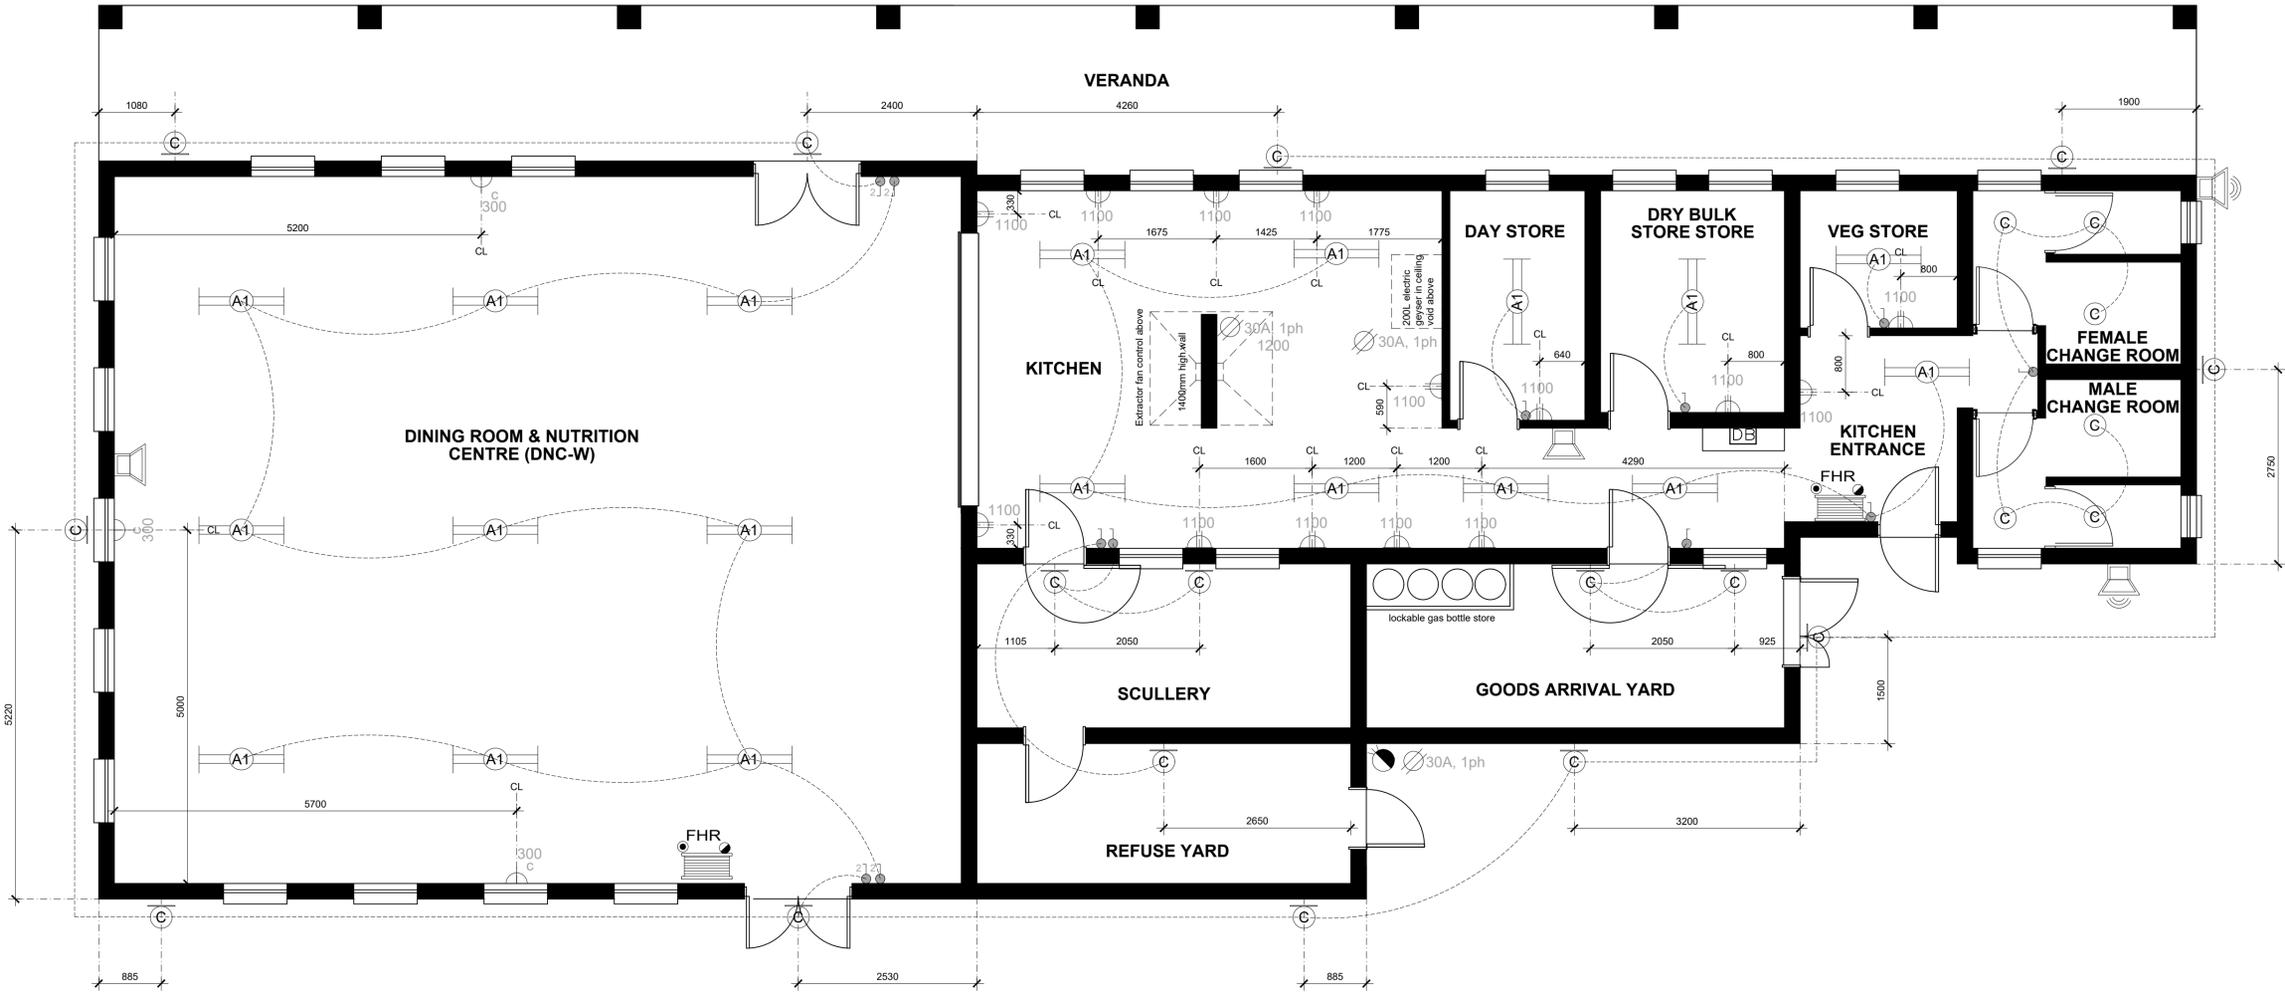

**BLOCK 2 - DINING & NUTRITION CENTRE ELECTRICAL LAYOUT**  
Scale 1:50